# SURFSIDE BEACH FISHING PIER RESTORATION

11 S Ocean Blvd, Surfside Beach, SC 29575

35% Design **Development** 8/30/2018 4701-172290





**ENGINEERS** 





## CIVIL


**GEL ENGINEERING** 2040 Savage Road Charleston, South Carolina tel: 843.556.8171 fax: 843.766.1178


**COLLINS ENGINEERS, INC.** 225 Seven Farms Drive, Suite 100 Charleston, South Carolina 29492 fax: 843.884.2028


LS3P ASSOCIATES LTD. 3067 Deville St. Myrtle Beach, South Carolina 29577 tel. 843.872.0360


# LANDSCAPE STRUCTURAL ARCHITECTURAL FIRE PROTECTION PLUMBING MECHANICAL ELECTRICAL

RMF ENGINEERING 194 Seven Farms Drive, Suite G Charleston, South Carolina 29492 tel: 843.971.9639 fax: 843.971.9641

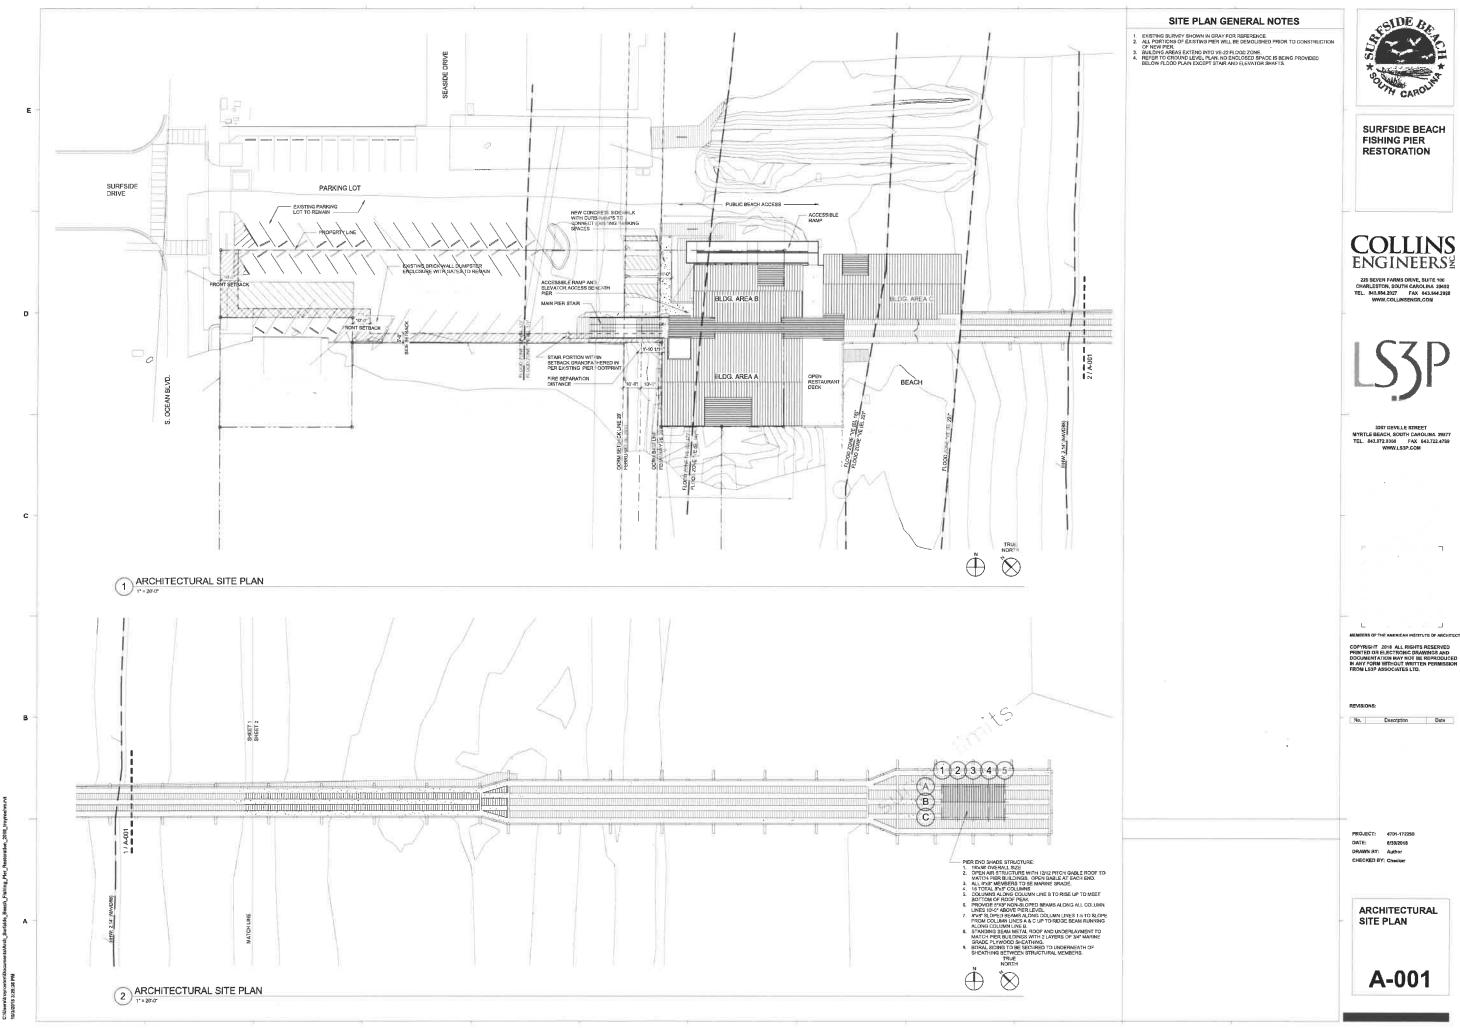


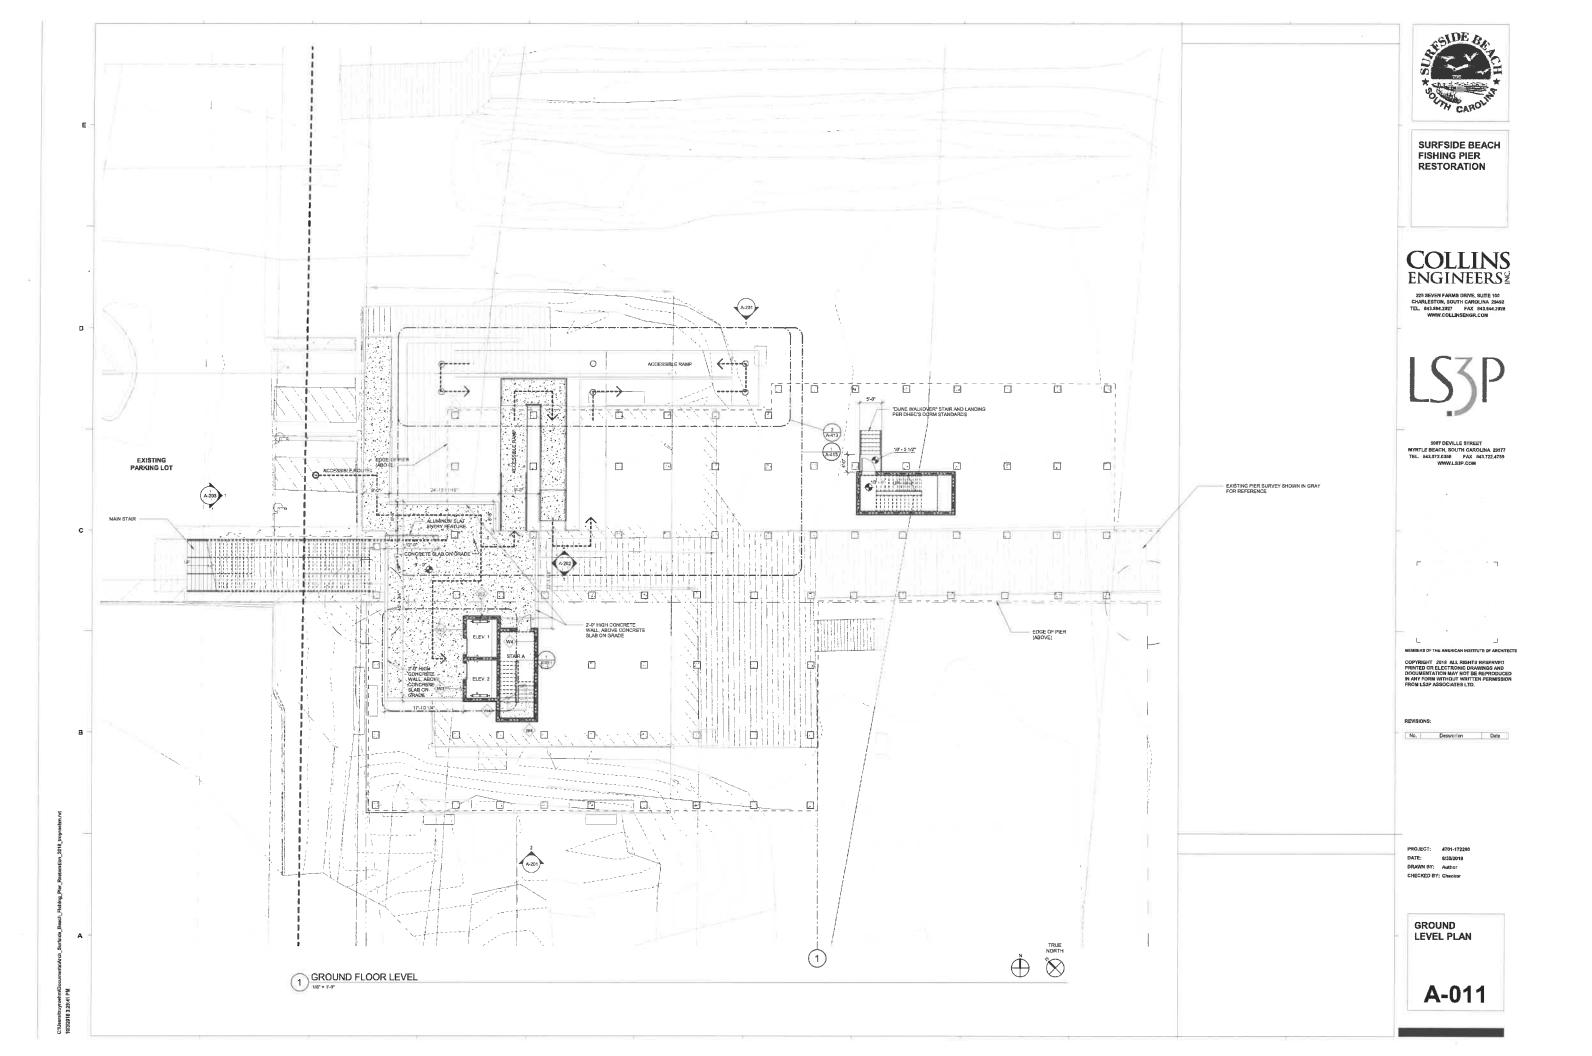

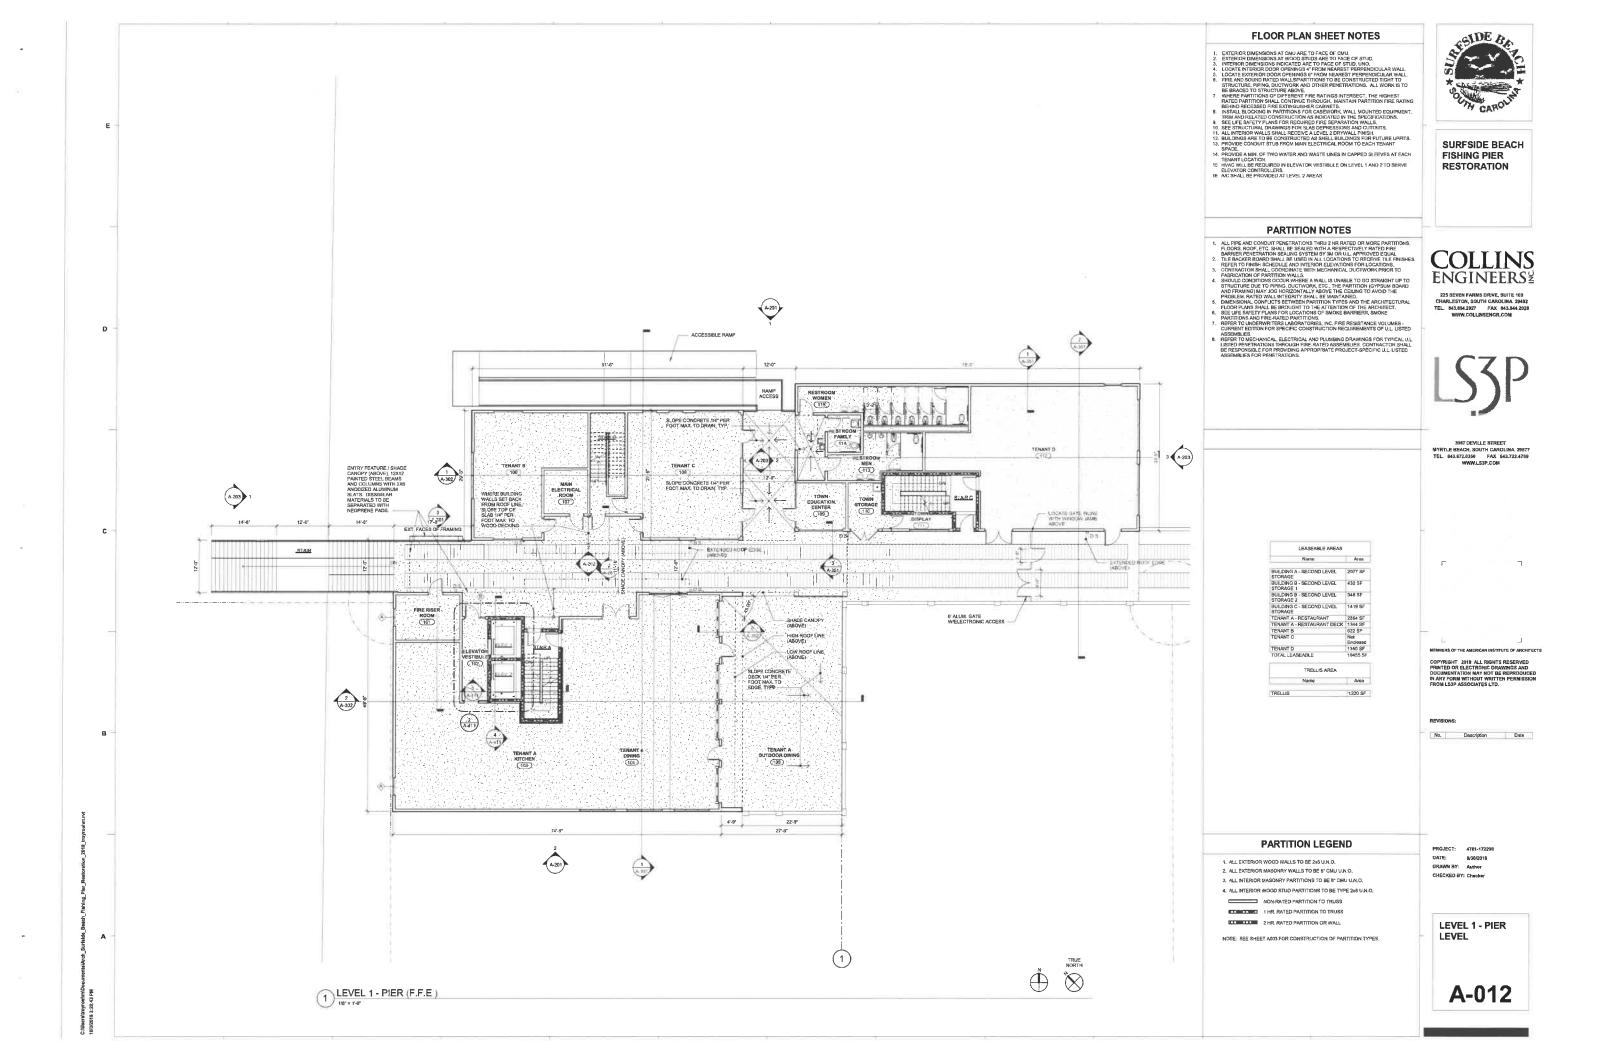

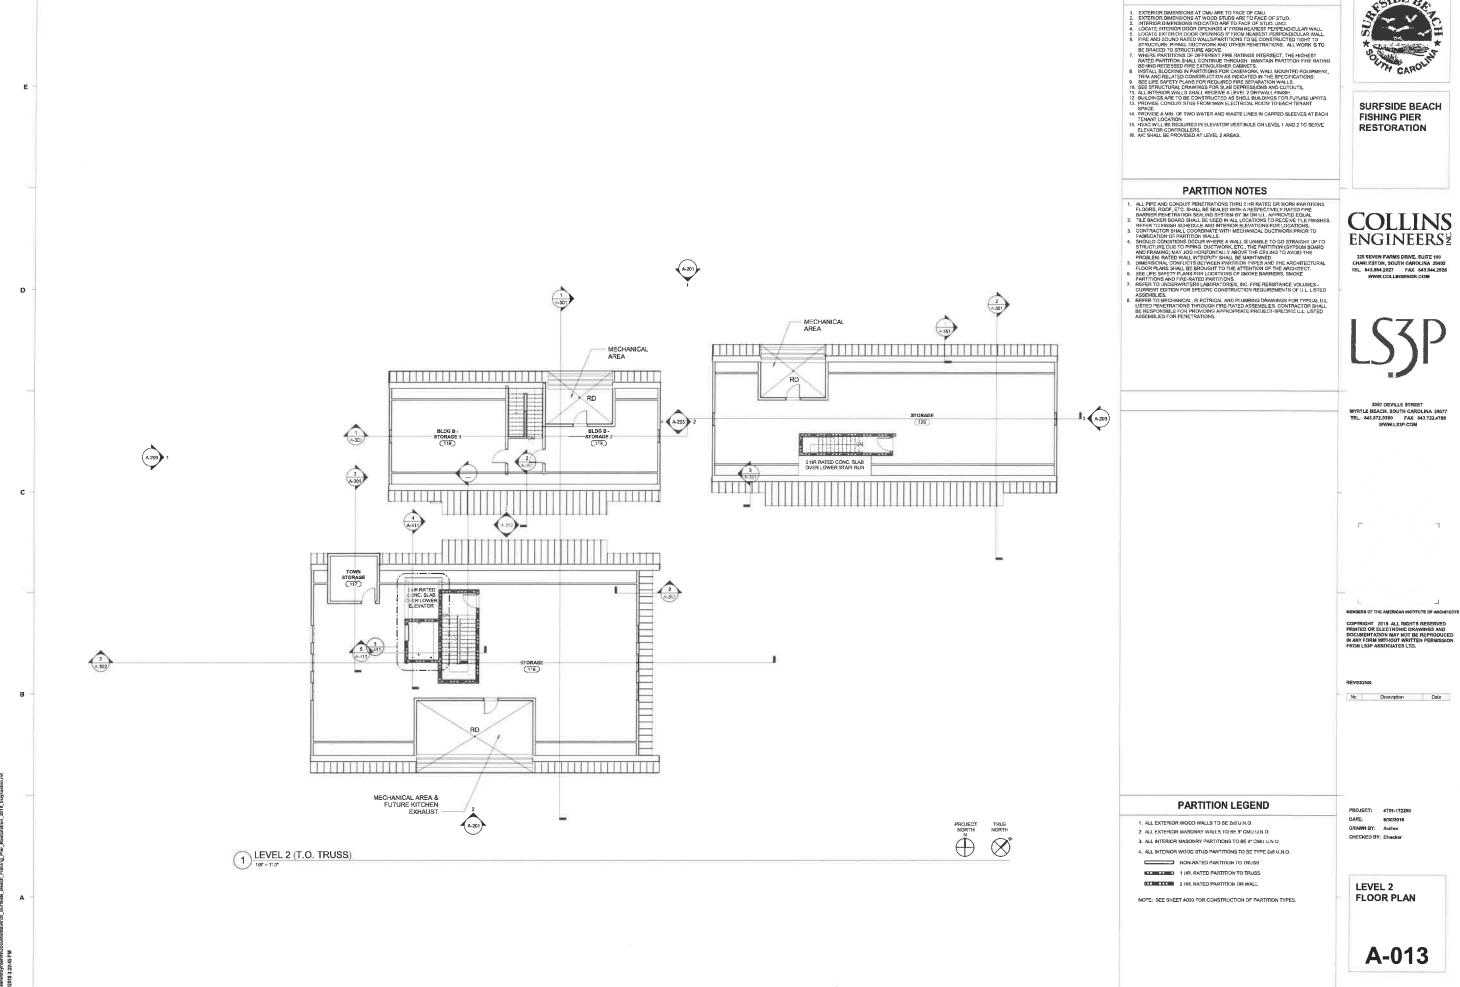



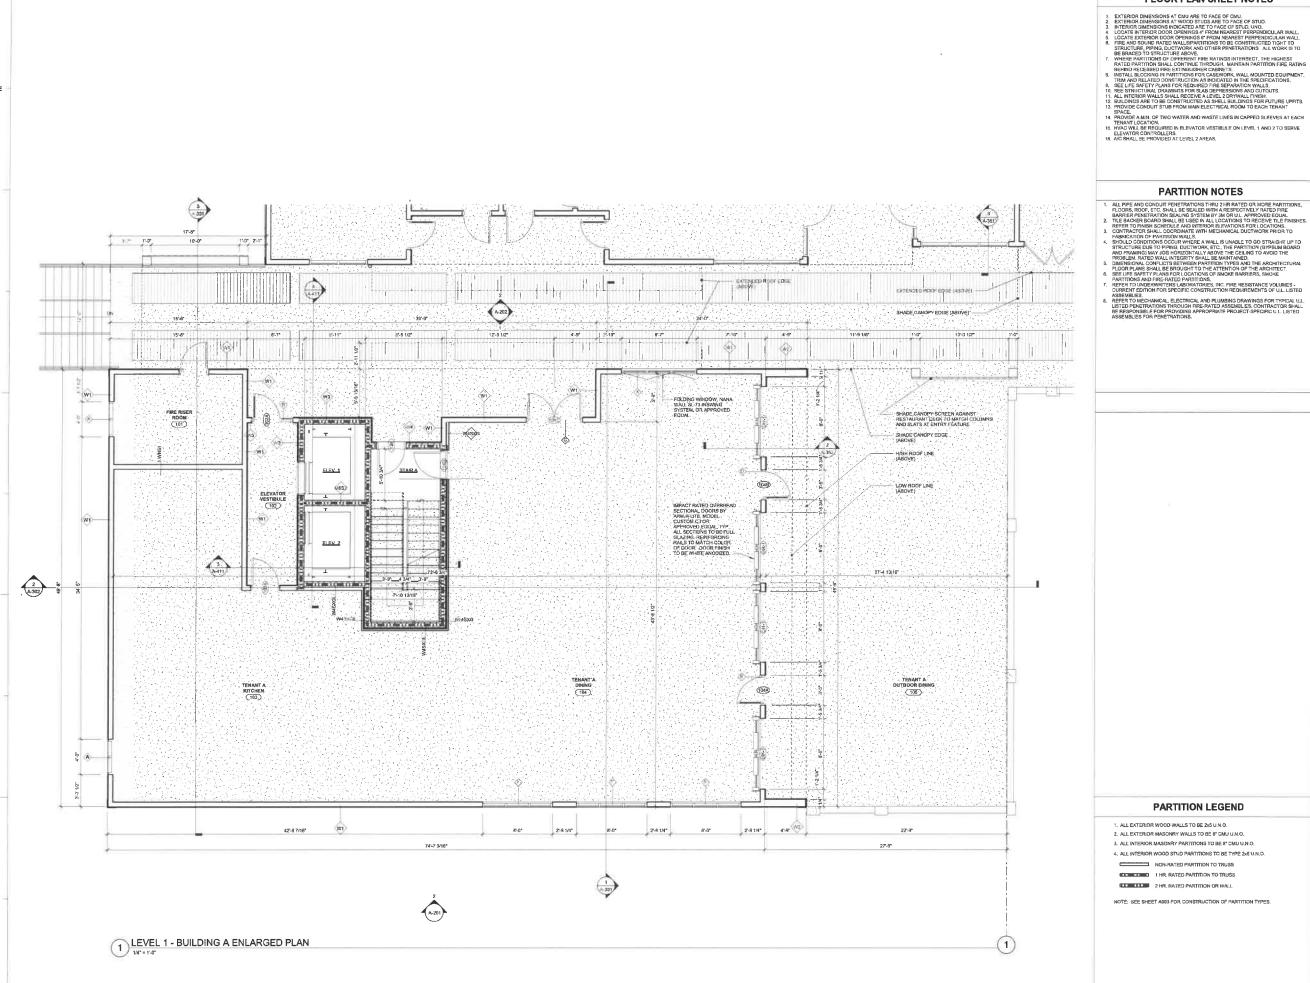

SURFSIDE BEACH FISHING PIER RESTORATION

#### **PARTITION NOTES**

- PARTITIONS AND FIRE-FATED PARTITIONS.
  REFER TO NUMEWHERES A LONG ATORIES, INC. FIRE RESISTANCE VOLUMES CURRENT EDMON FOR SPECIFIC CONSTRUCTION REQUIREMENTS OF U.L. LISTED
  ASSEMBLES.
  REFER TO MECHANICAL, ELECTRICAL AND PLUMBINS DRAWINGS FOR TYPICAL U.L.
  LISTED PENETRATIONS THROUGH FIRE-RATED ASSEMBLES. CONTRACTOR SHALL
  BE RESPONSIBLE FOR PROYONING APPROPRIATE PROJECT-SPECIFIC U.L. LISTED
  ASSEMBLES FOR PRETENTATIONS.

### **COLLINS ENGINEERS**

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3067 DEVILLE STREET FLE BEACH, SDUTH CAROLINA 29577 843.872.0360 FAX 843.722.4789 WWW.LS3P.COM

No. Description Date


### **PARTITION LEGEND**

- 1. ALL EXTERIOR WOOD WALLS TO BE 2x6 U.N.O.
- 3. ALL INTERIOR MASONRY PARTITIONS TO BE 8° CMU U.N.O.
- 4. ALL INTERIOR WOOD STUD PARTITIONS TO BE TYPE 2x6 U.N.O.
- NON-RATED PARTITION TO TRUSS

2 HR. RATED PARTITION OR WALL

PROJECT: 4701-172290 DRAWN BY: Author

> **BUILDING A-**LEVEL 1 (PIER)

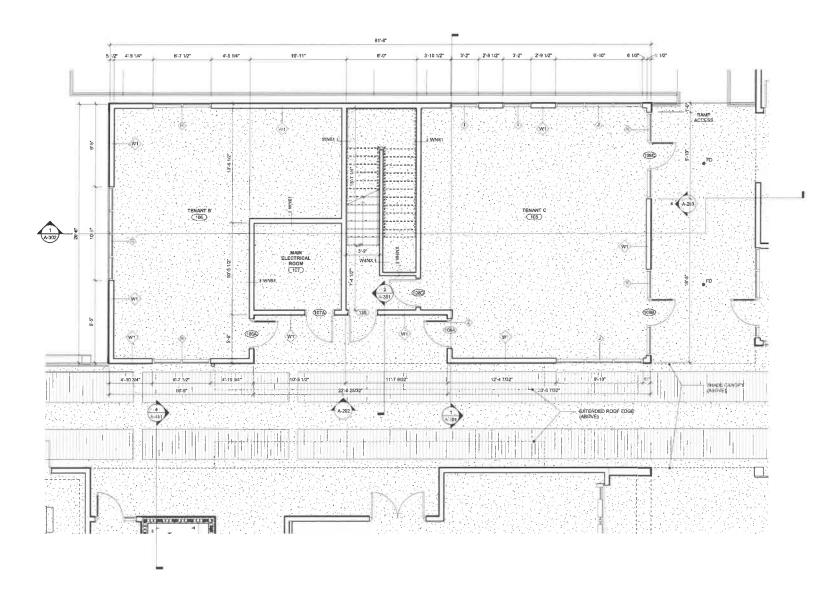

LEVEL 1 - BUILDING B ENLARGED PLAN

### FLOOR PLAN SHEET NOTES

- EXTERIOR DIMENSIONS AT ONLI ARE TO FACE OF ONLI
  EXTERIOR DIMENSIONS AT WOOD STUDS ARE TO FACE OF STUD
  INTERIOR DIMENSIONS NO MODE OF A TO FACE OF STUD
  INTERIOR DIMENSIONS NO MODE OF A TO FER OF STUD
  INTERIOR DIMENSIONS NO MODE OF A TO STUD IN ONLY
  LOCATE STERIOR DOOR OFENINGS 4° FROM NEAREST PERPENDICULAR WALL
  FIRE AND SOLURE RATED WALLSPACTITIONS TO BE CONSTRUCTED TIGHT TO
  STRUCTURE, PIPING, DICTIVING AND OTHER PERITATIONS, AU WORK IS TO
  STRUCTURE, PIPING, DICTIVING AND OTHER PERITATIONS, AU WORK IS TO
  MERITE PARTITIONS OF DIFFERENT FIRE RATINGS INTERSECT. THE HIGHEST
  RATED PARTITION SHALL CONTINUE THROUGH AN AMAINAR PARTITION FIRE RATING
  BEHIND RECESSED FIRE EXTINGUISHER CABINETS.
  HISTALE, BOTIONS IN PARTITIONS FOR CASS-WORK, WALL MOUNTED EQUIPMENT,
  TERM AND RELATED CONSTRUCTION SOLD IN THE SECURICATIONS.
  SEE STRUCTURE, DRAWNINGS FOR SAME DEFRESSIONS AND CUTUM.

  1. ALL INTERIOR WALLS SHALL RECEIVE A LEVEL 2 DRRYWALL FINISH.
  12. BUILDINGS ARE TO BE CONSTRUCTED AS MALE THE BUILDINGS FOR PUTURE UPPITS.
  13. PROVIDE CONDUIT STUD FROM MAIN ELECTRICAR ROOM TO EACH TERMAT

  SPACE.

- 15. PROVIDE CONDUIT STUB FROM MAIN ELECTRICAL ROUM TO EAUNT TETWORT SPACE.

  14. PROVIDE A NIN. OF TWO WATER AND WASTE LINES IN CAPPED SLEEVES AT EACH TEMANT LOCATION.

  15. HYAC WILL BE REQUIRED IN ELEVATOR VESTIBULE ON LEVEL 1 AND 2 TO SERVE BLEVATOR CONTROLLERS.

  16. AC SHALL BE PROVIDED AT LEVEL 2 AREAS.



SURFSIDE BEACH FISHING PIER RESTORATION

#### PARTITION NOTES

- PARTITION NOTES

  1. ALL PIPE AND CONDUIT PENETRATIONS THRU 2 HR RATED OR MORE PARTITIONS, II. AURAGE PROBLEM STATED HER SHARE PENETRATION SEALING SYSTEM BY 3M OR U.L. APPROVED EQUIP HER BRANKER PENETRATION SEALING SYSTEM BY 3M OR U.L. APPROVED EQUIP HER FINISHES. BRANKER PENETRATION SEALING SYSTEM BY 3M OR U.L. APPROVED FOR PENETRATION SEALING SYSTEM BY 3M OR U.L. APPROVED FOR PENETRATIONS OF A STATEMENT OF THE PENETRATION OF PENETRATION OF PENETRATION OF PARTITION AND LS.

  3. CONTRACTOR SHALL COORDINATE WITH MECHANICAL DUCTWORK PRIOR TO APPRICATION OF PARTITION WALLS.

  3. SHOULD CONDITIONS SECURITY MERE A WALL IS LIMBLE TO GO STRAIGHT UP TO STRUCTURE DUE TO PRIPING LOUTWORK, ETC. THE PARTITION GYPSIAL DID ARCHITECTURAL FLOOR FLOWER OF HER PARTITION OF PREATMENT AND THE PARTITIONS AND FREATHER STATED PARTITIONS.

  5. SELL PES BAFTY PLANS FOR LOCATIONS OF SMOKE BARRIERS, MONCE PARTITIONS AND FREATHED PARTITIONS.

  7. SEED FLY SHAPP YEARS FOR LOCATIONS OF SMOKE BARRIERS, MONCE PARTITIONS AND FREATHED PARTITIONS.

  7. SEED FLY SHAPP YEARS FOR LOCATIONS OF SMOKE BARRIERS, MONCE PARTITIONS AND FREATHED PARTITIONS.

  7. SEED FLY SHAPP YEARS FOR LOCATIONS OF SMOKE BARRIERS, MONCE PARTITIONS AND FREATHED PROTECTION FOR STEEPING CONSTRUCTION REQUIREMENTS OF U.L. LISTED PARTITIONS THROUGH FIRE-PARTED ASSEMBLIES. CONTRACTOR SHALL LISTED PENETRATIONS THROUGH FIRE-PARTED ASSEMBLIES. CONTRACTOR SHALL LISTED PENETRATIONS THROUGH FIRE-PARTED ASSEMBLIES. CONTRACTOR SHALL LISTED PARTETRATIONS THROUGH FIRE-PARTED ASSEMBLIES. CONTRACTOR SHALL LISTED PARTETRATIONS THROUGH FIRE-PARTED ASSEMBLIES. CONTRACTOR SHALL LISTED PARTETRATIONS THROUGH FIRE-PARTED ASSEMBLIES.

### COLLINS **ENGINEERS**

225 SÉVEN FARMS DRIVE, SUITE 100 CHARLESTON, SOUTH CAROLINA 29492 TEL. 843.884.2027 FAX 843.844.2028 WWW.COLLINSENGR.COM



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No. Description Date

### PARTITION LEGEND

- ALL EXTERIOR WOOD WALLS TO BE 2x6 U.N.O.
   ALL EXTERIOR MASONRY WALLS TO BE 8" CMU U.N.O.
- 3. ALL INTERIOR MASONRY PARTITIONS TO BE 8° CMU U.N.O. 4. ALL INTERIOR WOOD STUD PARTITIONS TO BE TYPE 2x6 U.N.O.
- 1 HR. RATED PARTITION TO TRUSS

Z HR. RATED PARTITION OR WALL

NOTE: SEE SHEET A003 FOR CONSTRUCTION OF PARTITION TYPES.

DATE: 8/30/2018

DRAWN BY: Author

BUILDING B -LEVEL 1 (PIER)

- 1. EXTERIOR DIMENSIONS AT CMU ARE TO FACE OF CMU
  2. EXTERIOR DIMENSIONS AT WOOD STUDS ARE TO FACE OF STUD.
  2. EXTERIOR DIMENSIONS AT WOOD STUDS ARE TO FACE OF STUD.
  3. EXPERIOR DIMENSIONS OF THE STUD STATE OF STUD.
  4. LOCATE INTERIOR DOOR OPENINGS IF FROM NEAREST PERSPENDICULAR WALL.
  5. FIRE AND SOLING RATED WALLSMARTHTONS TO BE CONSTRUCTED TIGHT TO
  5. FIRE AND SOLING RATED WALLSMARTHTONS TO BE CONSTRUCTED TIGHT TO
  7. WHERE PARTITIONS OF DIFFERENT FIRE RATINGS INTERSECT, THE HIGHEST
  RATED PARTITIONS OF DIFFERENT FIRE RATINGS INTERSECT, THE HIGHEST
  RATED PARTITIONS OF DIFFERENT FIRE RATINGS INTERSECT, THE HIGHEST
  RATED PARTITION SHALL CONTINUE THROUGH. MAINTAIN PARTITION FIRE RATING
  6. FINAND RECEIVED FIRE EXTRUSIVED AND CONTINUE THROUGH.
  7. TIMIN AND RELATED CONSTRUCTION AS INDICATED IN THE SPECIFICATIONS.
  9. SEE LIFE SAFETY FLANS FOR REQUIRED FIRE SEPARATION WALLS.
  10. SEE STRUCTURAL DRAWNINGS FOR BLAD SEPRESSIONS AND CUTTOUTS.
  11. SEE STRUCTURAL DRAWNINGS FOR BLAD SEPRESSIONS AND CUTTOUTS.
  12. BUILDINGS ARE TO BE CONSTRUCTED AS SHELL BUILDINGS FOR FUTURE UPTTS.
  13. PROVIDE CONDUIT STUD FROM MANY ELECTRICAL ROOM TO EACH TEMANT
  SPACE.
  14. AND STRUCTURED THE STRUCTURE OF THE STR



SURFSIDE BEACH FISHING PIER RESTORATION

#### **PARTITION NOTES**

- 1 ALL PIPE AND CONDUT FENETRATIONS THIN 2 HR BATED OR MORE PARTITIONS, R.DOORS, ROOK, ETC. SHALL BE SEALED WITH A RESPECTIVELY RATED FIRE BARRIER PREVENTATION SEALING SYSTEM BY 30 M OF U.L. APPROVED EQUAL.

  THE BROKER BOARD SHALL BE USED IN ALL LOCATIONS TO RECEIVE THE FINISHES. REPERT OF PHONE SCHOOL AND INTEROR ELEVATIONS FOR INCOLUNION. THE FINISHES. REPERT OF PHONE SCHOOL AND INTEROR ELEVATIONS FOR INCOLUNION. THE FINISHES AND INTEROR TO STRUCKTURE DUE TO PHONE DILLETHORNE, ETC., THE PARTITION (SYPSUM BIOARD FOR STRUCKTURE DUE TO PHONE DILLETHORNE, ETC., THE PARTITION (SYPSUM BIOARD FOR STRUCKTURE DUE TO PHONE DILLETHORNE, ETC., THE PARTITION (SYPSUM BIOARD FOR STRUCKTURE DUE TO PHONE DILLETHORNE, ETC., THE PARTITION (SYPSUM BIOARD FOR STRUCKTURE) AND INTEROPPING BOARD FOR SHALL BE BROKED AND THE ARCHITECTS.

  5 DIMENSIONAL COMPLICYS BETWEEN PARTITION TYPES AND THE ARCHITECTURAL FLOOR PLANS SHALL BE SHOUGHT TO THE ATTENTION OF THE ARCHITECTURAL FLOOR PLANS SHALL BE SHOUGHT TO THE ATTENTION OF THE ARCHITECTURAL FLOOR PLANS SHALL BE SHOORD STRUCTION REQUIREMENTS OF U.L. LISTED CUSPORER SHOULD STRUCTURE TO ASSEMBLES. CONTRACTOR SHALL BE RESPONDISHED FOR TRYOUGH FRE-PARTED ASSEMBLES.

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No. Description Date

### **PARTITION LEGEND**

- 1. ALL EXTERIOR WOOD WALLS TO BE 2x8 U.N.O.
- 2. ALL EXTERIOR MASONRY WALLS TO BE 8° CMU U.N.O.
- 3. ALL INTERIOR MASONRY PARTITIONS TO BE 8" CMU U.N.O.
- 4. ALL INTERIOR WOOD STUD PARTITIONS TO BE TYPE 2x6 U.N.O.

NON-RATED PARTITION TO TRUSS 1 HR. RATED PARTITION TO TRUSS

2 HR, RATED PARTITION OR WALL

PROJECT: 4701-172290 6/30/2016 DRAWN BY: Author

> BUILDING C -LEVEL 1 (PIER)

- 1. EXTERIOR DIMENSIONS AT CMU ARE TO FACE OF CMU.
  2. EXTERIOR DIMENSIONS AT WOOD STUDS ARE TO FACE OF STUD.
  3. EXTERIOR DIMENSIONS AT WOOD STUDS ARE TO FACE OF STUD.
  4. LOCATE INTERIOR DOOR OPENINGS 4" FROM NEAREST PERPENDICULAR WALL.
  5. FIRE AND SOUND RATED WALLSPARTITIONS TO BE CONSTRUCTED TIGHT TO STRUCTURE, PRIPE, DUDGWOOK AND OTHER PERTENTAIONS, ALL WORKS TO STRUCTURE, PRIPE, DUDGWOK AND OTHER PERTENTAIONS, ALL WORKS TO BE PRACED TO STRUCTURE ABOVE.
  5. REPARED PARTITION STALL CONTINUE THROUGH. MAINTAIN PARTITION FIRE ATTIMES BEHIND RECESSED FIRE EXTRICUISHER CABINETS.
  6. INSTALL BLOOMISH PARTITIONS FOR CASEWORK, WALL MOUNTED EQUIPMENT.
  7. TIME AND RELATED CONSTRUCTION AS INDICATED IN THE SPECIFICATIONS.
  8. INSTALL BLOOMISH PARTITIONS FOR CASEWORK, WALL MOUNTED EQUIPMENT.
  8. TIMES AND STALL STA

- 13 PROVIDE CONDITI STUB FROM MAIN BLECTRIKAL RUUM 10 FAUTH LEMANT SPACE.

  14. PROVIDE A MIN. OF TWO WATER AND WASTE LINES IN CAPPED SLEEVES AT EACH TEMANT LOCATION.

  15. HARC WILL BE REQUIRED IN ELEVATOR VESTIBULE ON LEVEL 1 AND 2 TO SERVE ELEVATOR CONTROLLERS.

  16. ACC SHALL BE PROVIDED AT LEVEL 2 AREAS.



SURFSIDE BEACH FISHING PIER RESTORATION

#### **PARTITION NOTES**

- 1. ALL PIPE AND CONDUT PENETTATIONS THRU 2 VIR RATED OR WORE PARTITIONS. PLONES ROOK ETC. SHALL BE SEALED WITH A SESPECTIVELY RATED RIPE BARRIER PENETTATION SEALING SYSTEM BY 30 M OF U. A PROVIDE GOULD.

  1. TILE BACKER BOARD SHALL BE USED IN ALL LOCATIONS TO RECEIVE TILE FINISHES. REPHET OF THIS SCHEDULE AND INTERIOR EVENTIONS FOR INCOLATIONS. REPHET OF THIS SCHEDULE AND INTERIOR EVENTIONS FOR INCOLATIONS. SHALL BE ASSETTED THE STATE OF THE PROVIDED THE PR

### **COLLINS ENGINEERS**<sup>2</sup>

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WWW.LS3P.COM

No. Description Date

### **PARTITION LEGEND**

- 1. ALL EXTERIOR WOOD WALLS TO BE 2x8 U.N.Q.
- 2. ALL EXTERIOR MASONRY WALLS TO BE 8" DMU U.N.O.
- 3. ALL INTERIOR MASONRY PARTITIONS TO BE 8" CMU U.N.O.
- NON-RATED PARTITION TO TRUSS

1 HR. RATED PARTITION TO TRUSS

2 HR, RATED PARTITION OR WALL

NOTE: SEE SHEET A003 FOR CONSTRUCTION OF PARTITION TYPES.

PROJECT: 4701-172290 DATE: 8/30/2018
DRAWN BY: Author

> **BUILDING A-**LEVEL 2

> > A-103

1 LEVEL 2 - BUILDING A ENLARGED PLAN

1 LEVEL 2 - BUILDING B ENLARGED PLAN

### FLOOR PLAN SHEET NOTES

- 1. EXTERIOR DIMENSIONS AT UNU ARE TO FACE OF CMU.
  2. EXTERIOR DIMENSIONS AT WOOD STUDS ARE TO FACE OF STUD.
  3. EXTERIOR DIMENSIONS AT WOOD STUDS ARE TO FACE OF STUD.
  4. LOCATE EXTERIOR DOOR OPENINGS & FROM NEAREST PERPENDICULAR WALL.
  5. FIRE AND SOUND RATED WALLSPARTHTONS TO BE CONSTRUCTED TIGHT TO
  6. FIRE AND SOUND RATED WALLSPARTHTONS TO BE CONSTRUCTED TIGHT TO
  7. WHERE PARTITIONS OF DEFERENT FIRE PATINGS. ALL WORKS TO
  8. BRACED TO STRUCTURE ABOVE.
  7. WHERE PARTITIONS OF DEFERENT FIRE PATINGS INTERSECT, THE HIGHEST
  8. RATED PARTITIONS FOR CONTINUE THROUGH. MAINTAIN PARTITION FIRE PATINGS.
  8. BESTALL BECAUSE ON PARTITIONS FOR CASEWORK WALL MOUNTED EQUIPMENT.
  7. TIPM AND RELATED CONSTRUCTED AS SHOULAND IN THE SPECIFICATIONS.
  9. SEE LIFE SAFETY PLANS FOR REQUIRED FIRE SEPARATION WALLS
  10. SEE STRUCTURAL DEWANNES FOR SLAD BENESSIONS AND LOTTO'LS.
  11. PROVIDE CONDUIT STUD FROM MAIN ELECTRICAL ROOM TO EACH TEMANT
  SPACE.
  12. BUILDINGS ARE TO BE CONSTRUCTED AS SHELL BUILDINGS FOR FUTURE UPFITS.
  13. PROVIDE CONDUIT STUD FROM MAIN ELECTRICAL ROOM TO EACH TEMANT
  SPACE.
  14. MIN OF TWO WATER AND WASTE LINES IN CAPPED SLEEVES AT EACH
  TEMANT LOCATION.
  15. HAVE WILL BE REQUIRED IN ELEVATOR VESTIBULE ON LEVEL 1 AND 2 TO SERVE
  ELEVATOR CONTIOLLERS.
  16. AC SHALL BE PROVIDED AT LEVEL 2 AREAS.



SURFSIDE BEACH FISHING PIER RESTORATION

#### **PARTITION NOTES**

- ALL PIPE AND COMOUT PENTATIONS THUS AND THE DOR NORE PARTITIONS, ELDORS RODE ETC. SHALL BE SEALED WITH A RESPECTIVELY PARTED RIRE ELOURS RODE ETC. SHALL BE SEALED WITH A RESPECTIVELY PARTED RIRE ELOURS RODE ETC. SHALL BE SEALED WITH A RESPECTIVELY PARTED RIRE BARRIER PENTATIONS SHALL BE USED IN ALL LOCATIONS TO RECEIVE TILE FINISHES. REPER TO PROMISH SICHEBUL A BOUND RIPE OF EVATIONS FOR ICCOLDING.

  A PROPERTY OF THE PARTITION WALLS.

  SHOULD CONDITIONS OCCUP WHERE A WALL IS UMABLE TO GO STRAIGHT UP TO STRUCTURE DUE TO PIPHING, DUCTWORK, ETC. THE PARTITION (SPPSUM BOARD PROBLEM ARTED WALL INTEGRITY SHALL BE MANT ARRED. DIAVIDITIES PROBLEM ARTED WALL INTEGRITY SHALL BE MANT ARRED. TO AVIOL THE PROBLEM ARTED WALL INTEGRITY SHALL BE MANT ARRED. THE ARCHITECTURAL FLOOR PLANS SHALL BE BROUGHT TO THE ATTENTION OF THE ARCHITECTURAL FLOOR PLANS SHALL BE RECORDED TO THE STRENGT OF THE PARTITION FLOOR PLANS HALL BE RECORDED TO THE PARTITION OF THE ARCHITECTURAL FLOOR PLANS SHALL BE RECEIVED. THE TOTTON FOR SPECIFIC CONSTRUCTION RECOVERNMENTS OF ULL LISTED CURRENT EDITION FOR SPECIFIC CONSTRUCTION RECOVERNMENTS OF ULL LISTED CURRENT EDITION FOR SPECIFIC CONSTRUCTION RECOVERNMENTS OF ULL LISTED CURRENT EDITION FOR SPECIFIC CONSTRUCTION RECOVERNMENTS OF ULL LISTED CURRENT STRUCTURE OF THE PARTITION OF THE PARTITION SPECIFIC CONTRACTOR SHALL BE RESPONSIBLE FOR PROVIDENCE APPROPRIATE PROJECT-SPECIFIC ULL LISTED ASSEMBLES. CONTRACTOR SHALL BE RESPONSIBLE FOR PROVIDING APPROPRIATE PROJECT-SPECIFIC ULL LISTED ASSEMBLES FOR PRETERTICINS.

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No. Description Date

### **PARTITION LEGEND**

- 2. ALL EXTERIOR MASONRY WALLS TO BE 8" CMU U.N.O. 3. ALL INTERIOR MASONRY PARTITIONS TO BE 8" CMU U.N.O.
- 4. ALL INTERIOR WOOD STUD PARTITIONS TO BE TYPE 2x6 U.N.O.

NON-RATED PARTITION TO TRUSS 1 HR. RATED PARTITION TO TRUSS

2 HR. RATED PARTITION OR WALL

NOTE; SEE SHEET A003 FOR CONSTRUCTION OF PARTITION TYPES.

PROJECT: 4781-172290 DATE: 8/30/2016 DRAWN BY: Author 8/30/2016

**BUILDING B** -LEVEL 2

A-104

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- 1. EXTERIOR DIMENSIONS AT CMU ARE TO FACE OF CMU.
  2. EXTERIOR DIMENSIONS AT WOOD STUDG ARE TO FACE OF STUD.
  3. EXTERIOR DIMENSIONS AT WOOD STUDG ARE TO FACE OF STUD.
  4. LOCATE WITERIOR DOOR OPENINGS 4" FROM NEAREST PERPENDICULAR WALL.
  5. FIRE AND SOLIND RATED WALL SHARTHONS TO BE CONSTRUCTED TRIGHT TO
  5. STUDGED TO STRUCTURE ADVIS.
  6. FIRE AND SOLIND RATED WALL SHARTHONS TO BE CONSTRUCTED TRIGHT TO
  5. BE SHACED TO STRUCTURE ADVIS.
  7. WHERE PARTITIONS OF DEFERENT FIRE PATTINGS INTERSECT. THE HIGHEST
  6. RATED PARTITIONS OF DEFERENT FIRE PATTINGS INTERSECT. THE HIGHEST
  7. RATED PARTITIONS AND CONTINUE THROUGH, MAINTAIN PARTITION FIRE PATTING
  6. SHART DEFENDED THE EXTINGUISHER CASINGTS.
  7. SHE LIFE SAFETY PLANS FOR RECUIRED FIRE SEPARATION WALLS.
  7. SHE LIFE SAFETY PLANS FOR RECUIRED FIRE SEPARATION WALLS.
  7. SHE LIFE SAFETY PLANS FOR RECUIRED FIRE SEPARATION WALLS.
  7. SHE LIFE CONDUIT STUD FROM MAIN ELECTRICAL ROOM TO EACH TENANT
  7. SHARL SHA



SURFSIDE BEACH FISHING PIER RESTORATION

#### **PARTITION NOTES**

- ALL PIPE AND COMOUT CENTERATIONS THIS J. P. RATED OR MORE PARTITIONS, PLOORS, 300F, ETC. SHALL BE STALED WITH A RESPIRITIVE Y NATED FIRE BARRIER RENETRATION SEALING SYSTEM BY MO OF ILL APPROVED EQUAL.

  THE BACKER BOARD SHALL BE USED IN ALL LOCATIONS TO RECEIVE THE FINISHES. REPER TO PRINSI SCHEDULE AND INTERIOR DELEVATIONS FOR LOCATIONS.

  FREED TO PRINSI SCHEDULE AND INTERIOR DELEVATIONS FOR COATIONS.

  SHOULD CONDITIONS OCCUR. SHOULD HE REPARTITION DUTY WORK PRIOR TO SIRUCTURE DUE TO PAPIN, DUCTWORK, PICE, THE PARTITION (GYPSIM BOARD STRUCTURE DUE TO PAPIN, DUCTWORK, PICE, THE PARTITION (GYPSIM BOARD STRUCTURE DUE TO PAPIN, DUCTWORK, PICE, THE PARTITION (GYPSIM BOARD STRUCTURE DUE TO PAPIN, DUCTWORK, PICE, THE PARTITION (GYPSIM BOARD STRUCTURE DUE TO PAPIN, DUCTWORK, PICE, THE PARTITION ON YOUR THE PROBLEM ARED WALL INTEGERY SHALL BE MANTAINED.

  5. DIMENSIONAL CONFLICTS BETWEEN PARTITION TYPES AND THE ARCHITECT.

  6. PORTITION WHAT PREPARED TO PARTITION OF SHOKE BARKERS, SHOKE THE PARTITION OF THE ARCHITECT AND THE PROBLEM PARTITION OF SHOKE BARKERS, SHOKE CHARGES AND THE PARTITION OF THE ARCHITECT AND THE PARTITION OF THE RESTATION OF THE ARCHITECT AND THE PARTITION OF THE RESTANCE VOLUMES OURSELF COMPRISED DARTITIONS. BOARD FOR PICE AND THE PARTITION OF THE PA

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No. Description Date

### PARTITION LEGEND

- 1. ALL EXTERIOR WOOD WALLS TO SE 2x8 U.N.O.
- 2. ALL EXTERIOR MASONRY WALLS TO BE 8" CMU U.N.O.
- 3. ALL INTERIOR MASONRY PARTITIONS TO BE 8" CMU U.N.O. 4. ALL INTERIOR WOOD STUD PARTITIONS TO BE TYPE 2x8 U.N.O.
- NON-RATED PARTITION TO TRUSS

1 HR, RATED PARTITION TO TRUSS

2 HR, RATED PARTITION OR WALL


NOTE: SEE SHEET A003 FOR CONSTRUCTION OF PARTITION TYPES.

PROJECT: 4701-172290 DATE: 8/30/2018 DRAWN BY: Author

BUILDING C -LEVEL 2


A-105


1 LEVEL 2 - BUILDING C ENLARGED PLAN

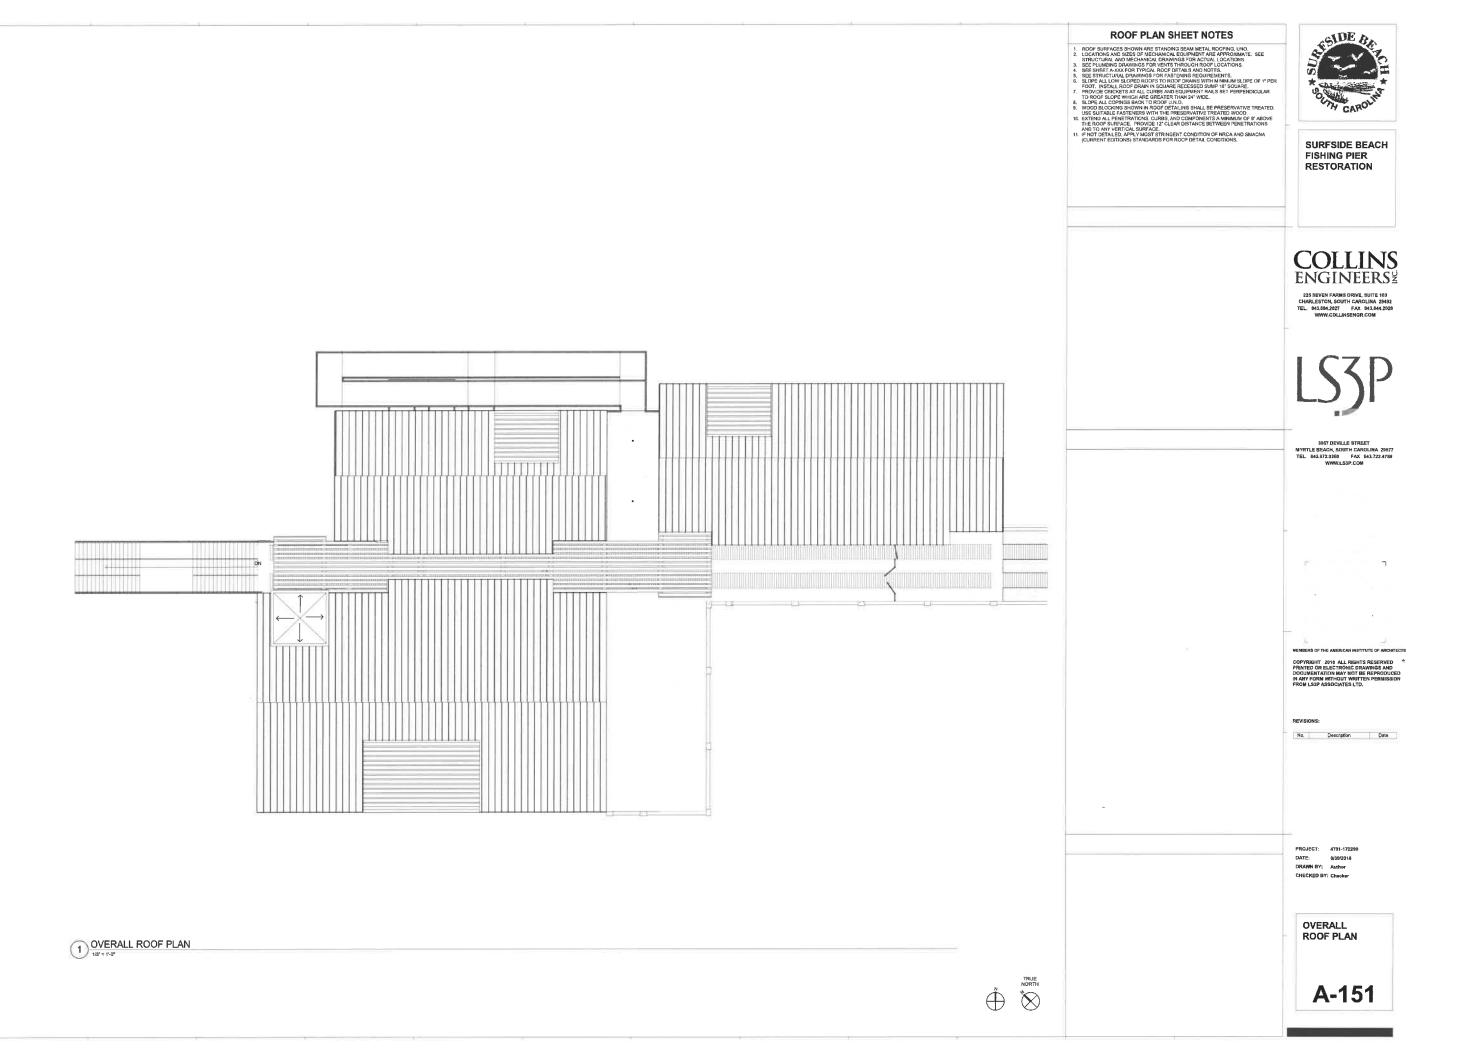


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SURFSIDE BEACH FISHING PIER RESTORATION

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No. Description Date

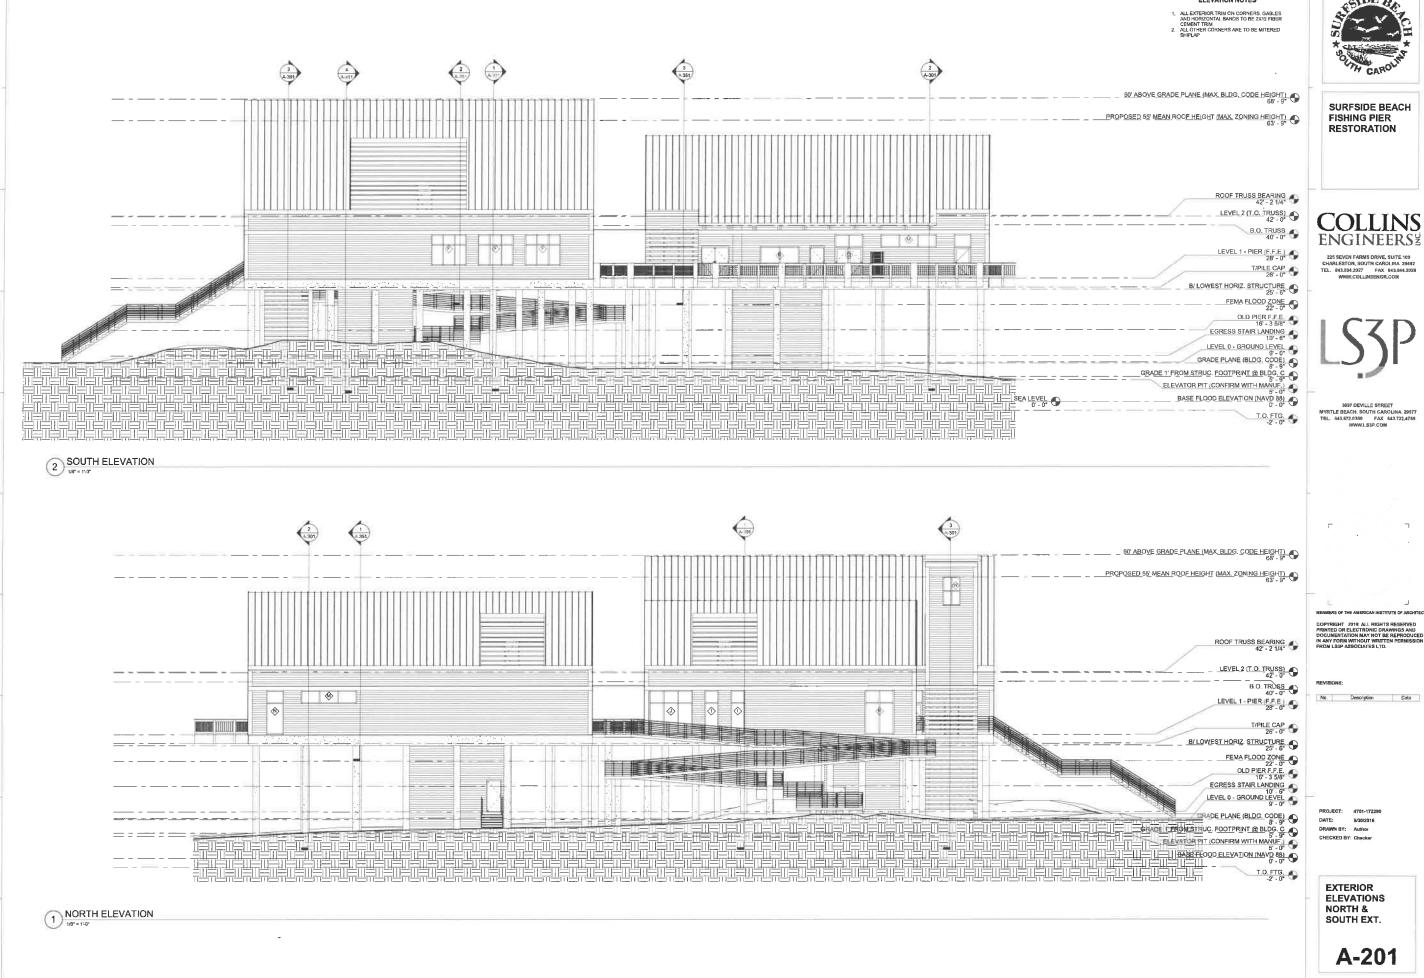PROJECT: 4701-17229 DATE: 8/30/2018 DRAWN BY: Author CHECKED BY: Checker

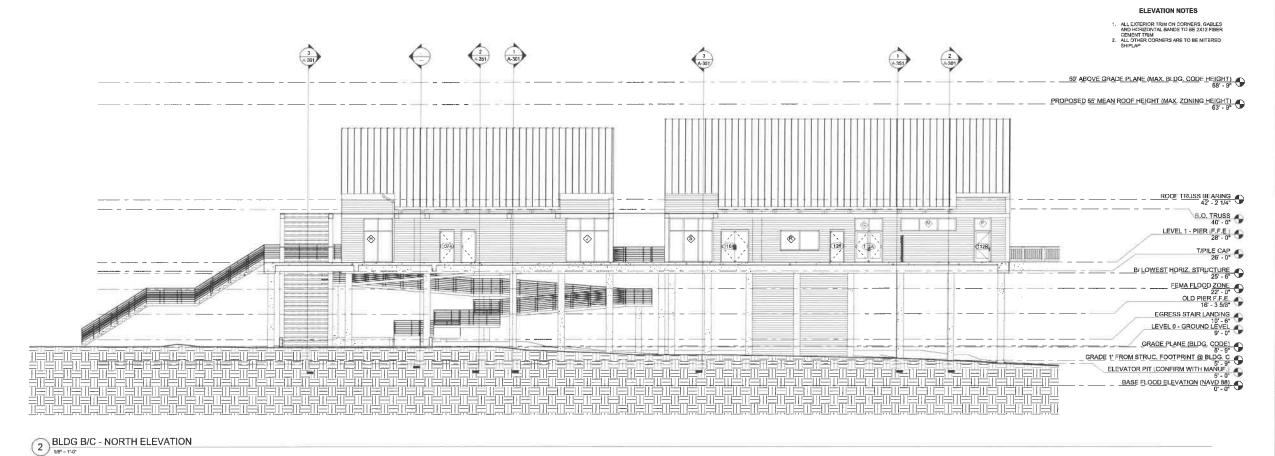EXTERIOR ELEVATIONS NORTH & SOUTH INT. (PIER)

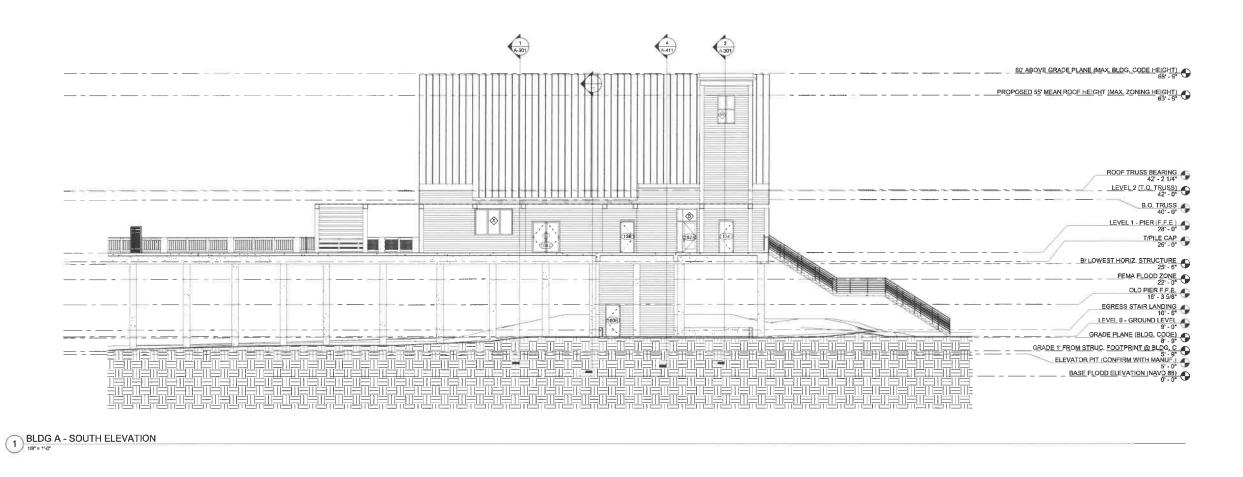

 ALL EXTERIOR TRIM ON CORNERS, GABLES AND HORIZONTAL BANDS TO BE 2X12 FIBER CEMENT TRIM
 ALL OTHER CORNERS ARE TO BE MITERED SHIPLAP



SURFSIDE BEACH FISHING PIER RESTORATION

COLLINS ENGINEERS<sup>2</sup>

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REVI


No. Description Date

PROJECT: 4701-172290
DATE: 8/30/2018
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EXTERIOR ELEVATIONS -EAST & WEST EXT. AND INT. (PIER)

A-203



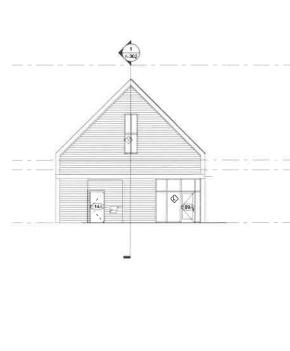



WEST ELEVATION

1/8" = 1'-0"

2 BLDG C - WEST ELEVATION

BY AND YEAR BOOK HEIGHT MAX SURG, CODE HEIGHT OF PROPOSED 27 MEAN BOOK HEIGHT MAX ZONING HEIGHT OF THE STRUCK SURGE AND SURGE

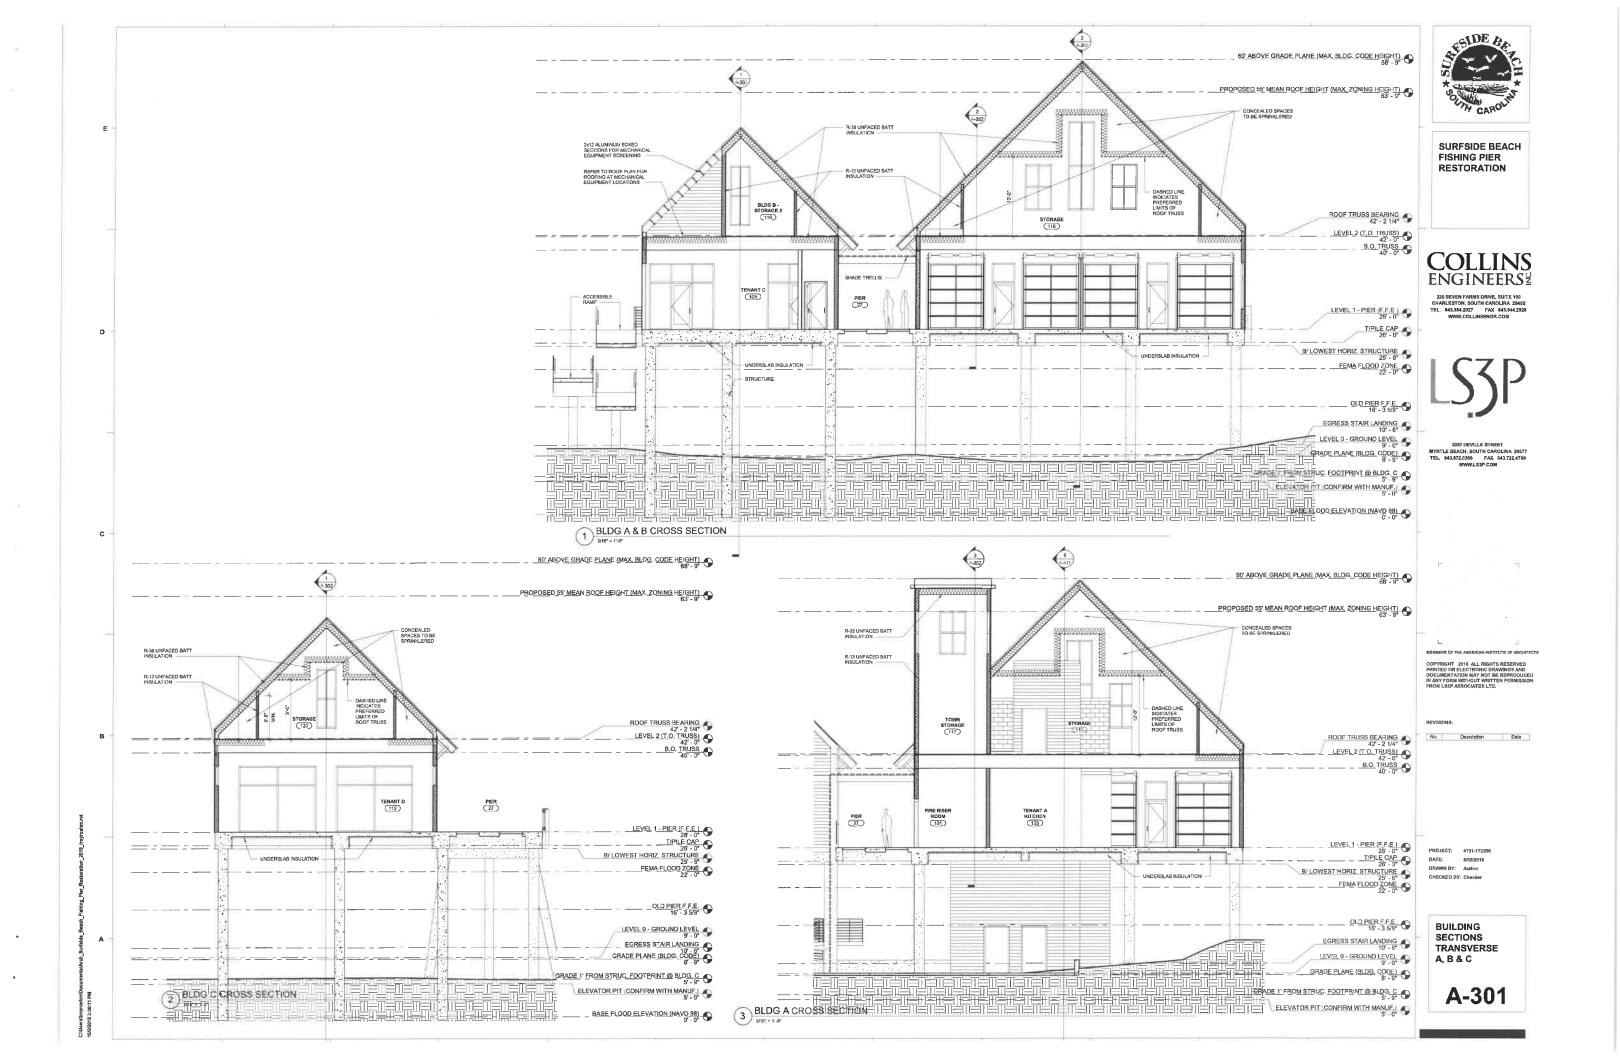

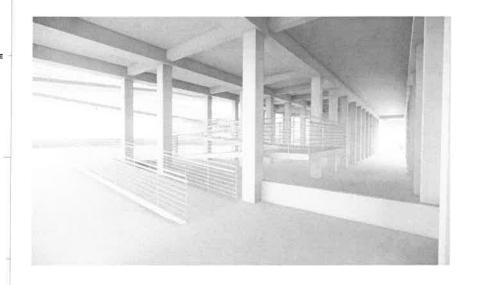

18' - 6 1/4" 25' - 7 9/16"


GROUND LEVEL RAMP ACCESS



VIEW OF RAMP LOOKING TOWARD GROUND LEVEL ACCESS



OCEANSIDE VIEW OF RAMP

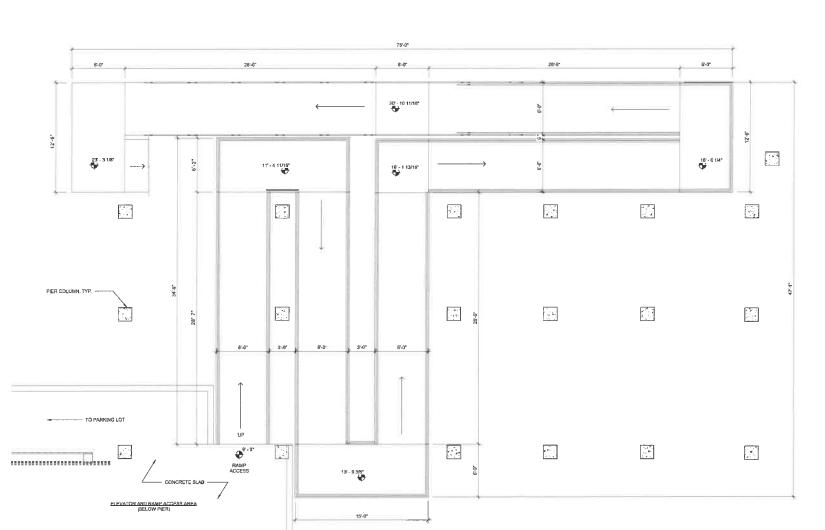

1 LEVEL 0 - ENLARGED RAMP PLAN (LOWER PORTION)

2 LEVEL 0 - ENLARGED RAMP PLAN (UPPER PORTION)



SURFSIDE BEACH FISHING PIER RESTORATION

COLLINS ENGINEERS 2

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RAMP PLANS AND VIEWS